


REVISIONS


|-12-22 ADDED DEAD 22" & 29" LAUREL DAKS TO BE REMOVED AND 15" LAUREL OAI TO BE RELOCATED. 6-9-22 REVISED SIDEWALK, PAY STATION AND DRIVE LOCATIONS. 10-4-22 REVISED SS AND WATER SERVICE LOCATIONS, REVISED C.B. RD. RIGHT OF WAY DRAINAGE.

A

H

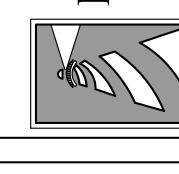


PROTECTION

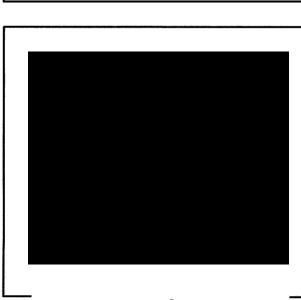

CLIENT INFORMATION: Andy Lazzaro Three Guys Car Wash, Llc 5520 Oleander Dr. Wilmington, NC 28403

DRAWN:	JAE	SHEET SIZE:	24 X 36
CHECKED:	CDC	DATE:	1/31/2022
APPROVED:	CDC	SCALE:	1" = 30'
PROJECT NUMBER:		2021-035	



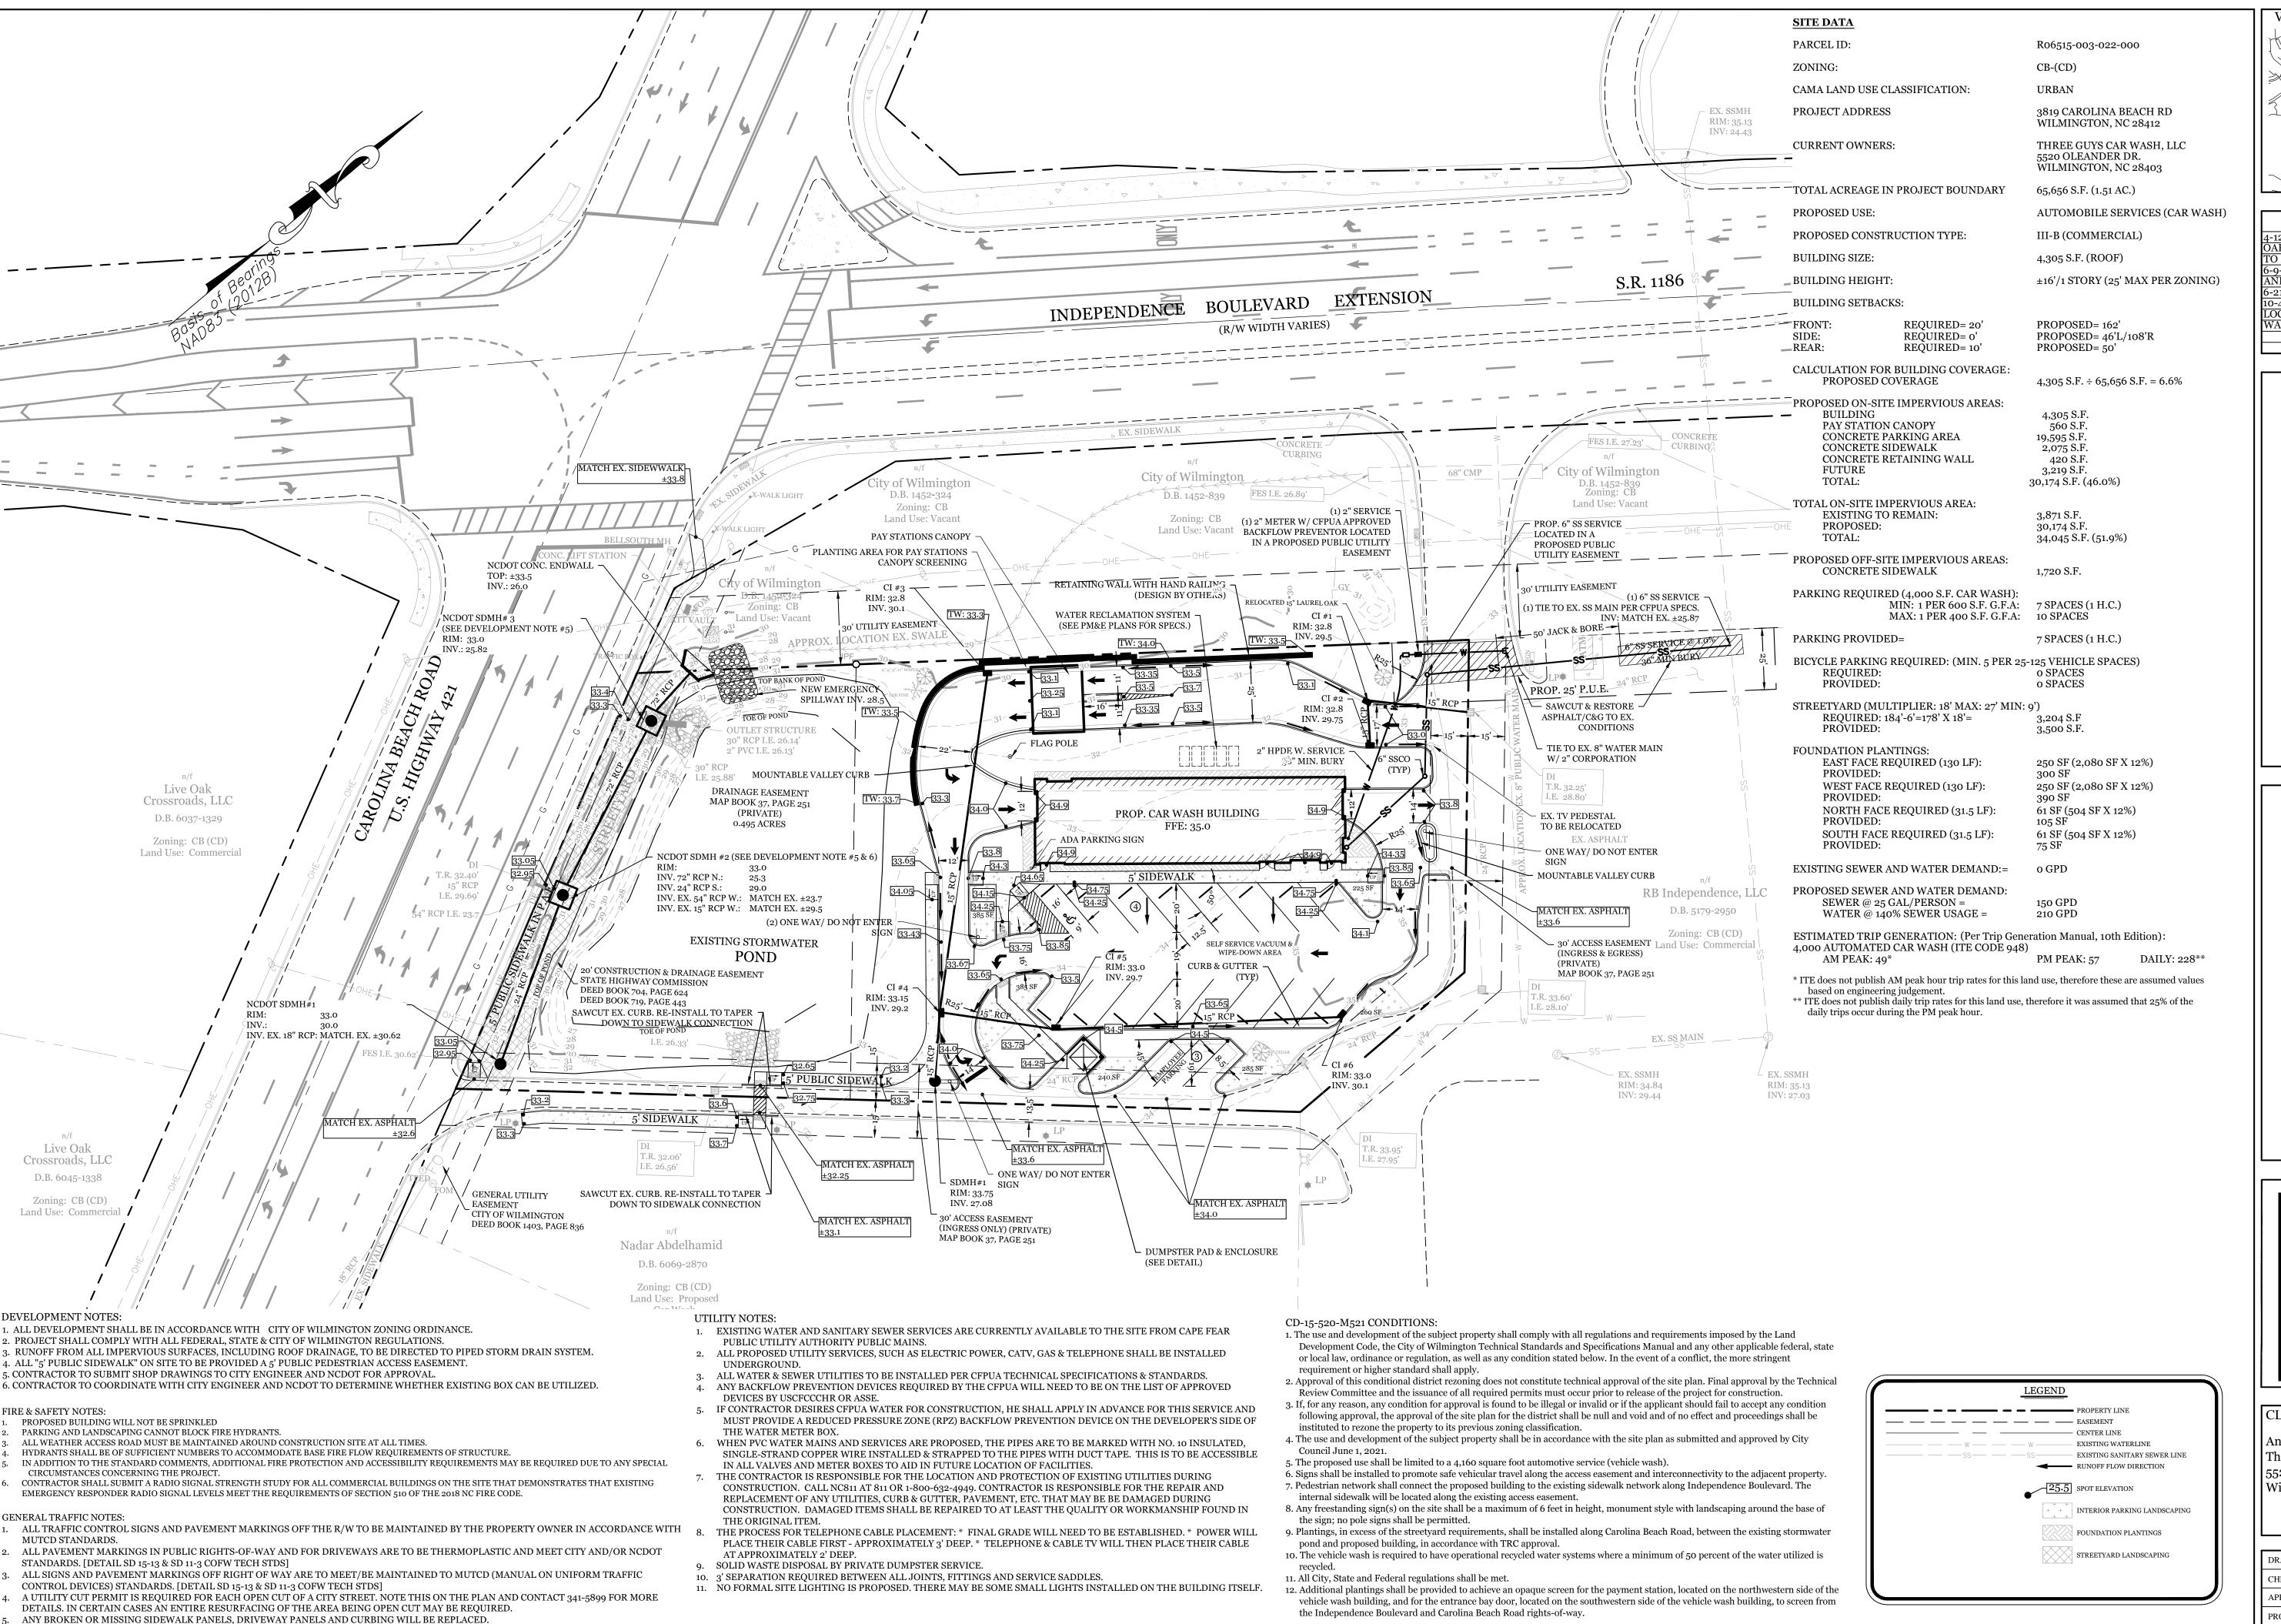

CONTACT 811 PRIOR TO CONTACTING CITY OF WILMINGTON, TRAFFIC ENGINEERING REGARDING THE UTILITIES IN ROW.

STREET TREES MUST BE LOCATED A MINIMUM OF 15 FEET FROM STREET LIGHTS. [COFW SD 15-17]

DETAILS. IN CERTAIN CASES AN ENTIRE RESURFACING OF THE AREA BEING OPEN CUT MAY BE REQUIRED.

ALL PROPOSED VEGETATION WITHIN SIGHT TRIANGLES SHALL NOT INTERFERE WITH CLEAR VISUAL SIGHT LINES FROM 30" TO 10'.


A UTILITY CUT PERMIT IS REQUIRED FOR EACH OPEN CUT OF A CITY STREET. NOTE THIS ON THE PLAN AND CONTACT 341-5899 FOR MORE


VICINITY MAP (NOT TO SCALE):

REVISIONS -12-22 ADDED DEAD 22" & 29" LAUREL AKS TO BE REMOVED AND 15" LAUREL OA O BE RELOCATED. 5-9-22 REVISED SIDEWALK, PAY STATION AND DRIVE LOCATIONS. 6-21-22 REVISED SS TIE-IN LOCATION. 10-4-22 REVISED SS AND WATER SERVICE OCATIONS, REVISED C.B. RD. RIGHT OF

WAY DRAINAGE.

d

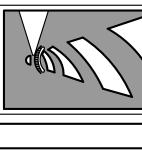


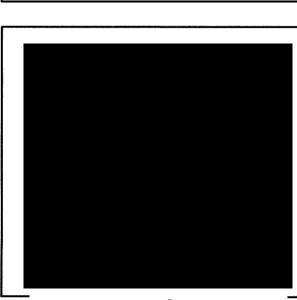

CLIENT INFORMATION: Andy Lazzaro Three Guys Car Wash, Llc 5520 Oleander Dr. Wilmington, NC 28403

DRAWN:	JAE	SHEET SIZE:	24 X 36
CHECKED:	CDC	DATE:	1/31/2022
APPROVED:	CDC	SCALE:	1" = 30'
PROJECT NUMBER:		2021-035	

DRAWING NUMBER: C-1

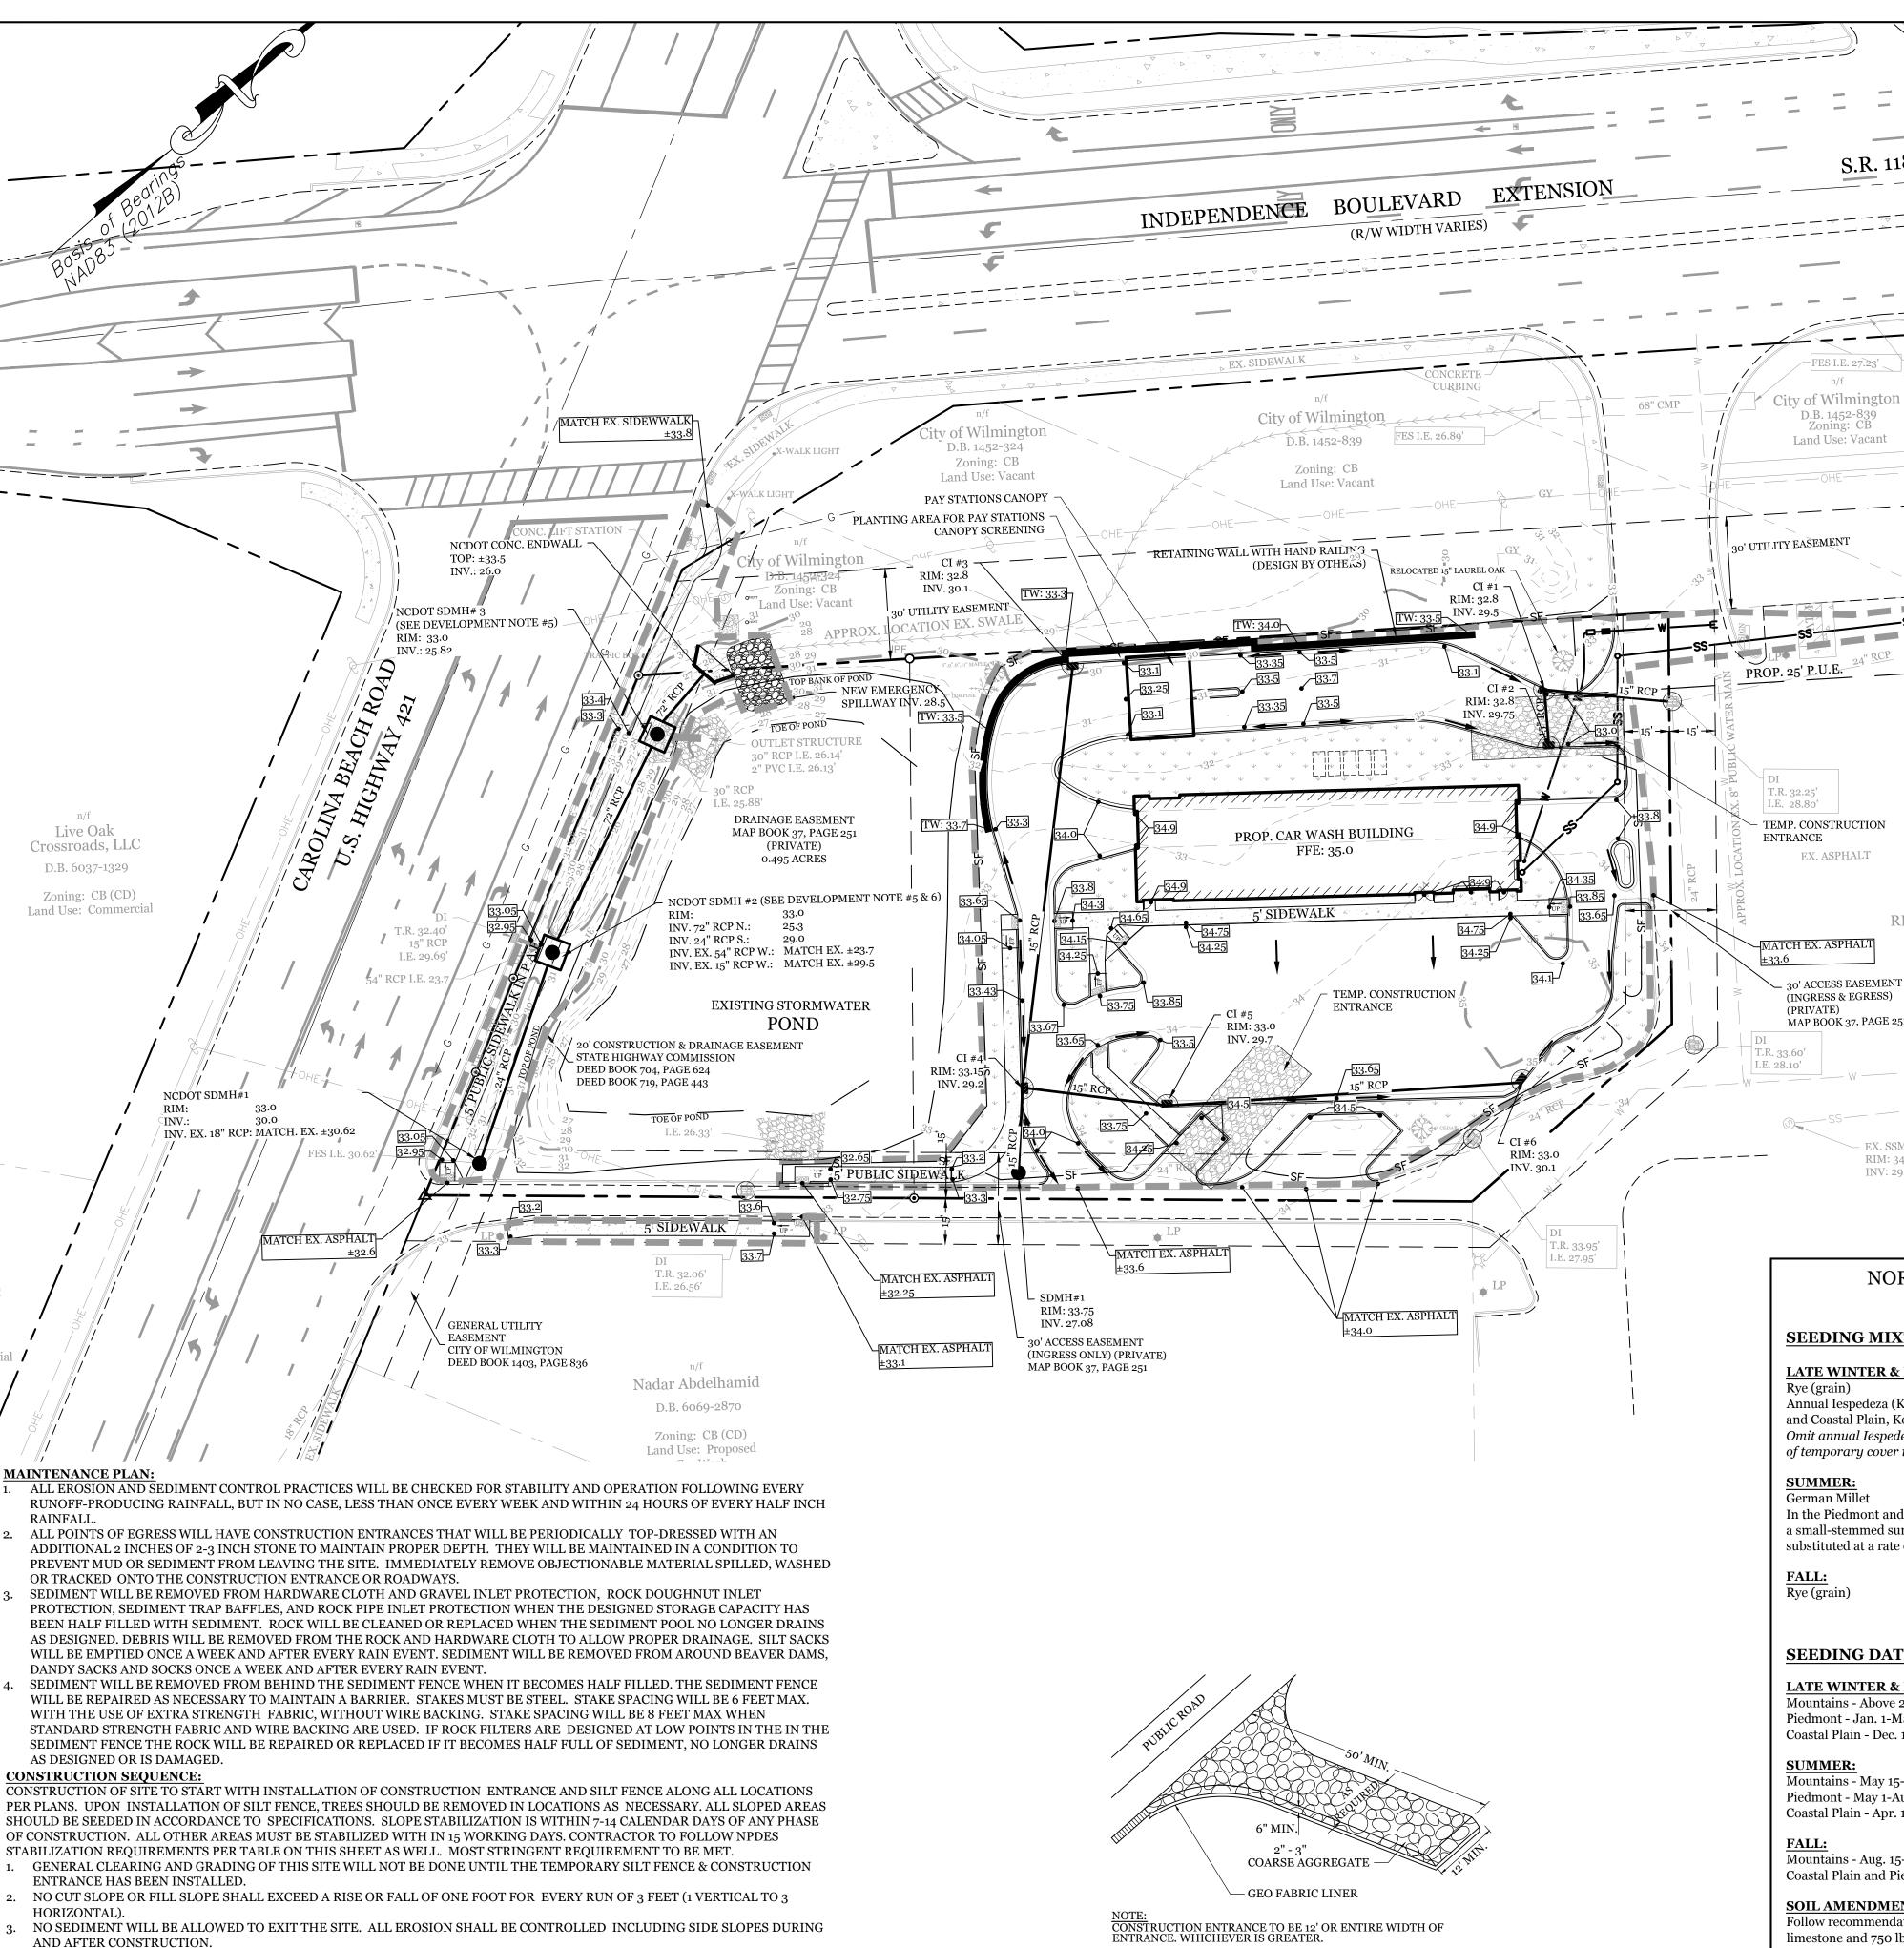

GRAVELED CONSTRUCTION ENTRANCE, SILT FENCE, TREE PROTECTION FENCE & SEDIMENT BASINS, INSTALL ALL SECONDARY

ALL EROSION CONTROL MEASURES TO BE INSPECTED AFTER EACH RAIN. SILT FENCE AND INLET PROTECTION TO BE CLEANED

MORE STRINGENT MEASURES MAY BE REQUIRED TO HALT EROSION IF THOSE ON THIS PLAN PROVE TO BE LESS EFFECTIVE.

REMOVE ALL TEMPORARY EROSION CONTROL MEASURES UPON COMPLETION OF CONSTRUCTION. ALL PERMANENT MEASURES

EROSION CONTROL MEASURES, SUCH AS INLET PROTECTION AS SOON AS POSSIBLE AFTER BEGINNING CONSTRUCTION.

6. A 4" LAYER OF TOPSOIL SHALL BE APPLIED TO ALL NEW AREAS TO BE GRASSED. MAINTAIN ALL EROSION CONTROL MEASURES UNTIL PROJECT IS COMPLETE.

SHALL BE WELL ESTABLISHED PRIOR TO PROJECT COMPLETION.

WHEN HALF FULL.

TEMPORARY GRAVEL

CONSTRUCTION ENTRANCE

— CURRENT OWNERS

PARCEL ID:

SITE DATA

CAMA LAND USE CLASSIFICATION:

PROJECT ADDRESS

3819 CAROLINA BEACH RD WILMINGTON, NC 28412 THREE GUYS CAR WASH, LLC

5520 OLEANDER DR.

WILMINGTON, NC 28403

CB-(CD)


URBAN

R06515-003-022-000

TOTAL ACREAGE IN PROJECT BOUNDARY 65,656 S.F. (1.51 AC.)

TOTAL DISTURBED AREA: 1.0 AC.

> 5-9-22 REVISED SIDEWALK, PAY STATION AND DRIVE LOCATIONS. 0-21-22 REVISED SS TIE-IN LOCATION. 0-4-22 REVISED SS AND WATER SERVICE OCATIONS, REVISED C.B. RD. RIGHT OF WAY DRAINAGE. MOVED TEMP. CONST. NTRANCE DETAIL FROM SHEET C

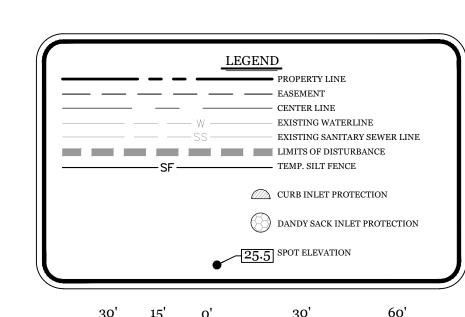

SYMBOL	GROUND STABILIZATION CRITERIA		
	SITE AREA DESCRIPTION	STABILIZATION TIMEFRAME	STABILIZATION TIMEFRAME EXCEPTIONS
	* Perimeter dikes, swales, ditches and slopes	7 Days	None
	* High Quality Water (HQW) Zones	7 Days	None
	* Slopes Steeper than 3:1	7 Days	If slopes are 10' or less in length and are not steeper than 2:1, 14 days are allowed
\(\psi\) \(\	* Slopes 3:1 or flatter	14 Days	7-days for slopes greater than 50 ft. in length
\(\psi \)	* All other areas with slopes flatter than 4:1	14 Days	None (except for perimeters & HQW Zones)

NORTH CAROLINA TEMPORARY CDACCINC DETAIL

EX. SSMH RIM: 35.13

INV: 27.03

RB Independence, LLC

D.B. 5179-2950

Zoning: CB (CD)

30' ACCESS EASEMENT Land Use: Commerc

RIM: 34.84

INV: 29.44

(INGRESS & EGRESS)

MAP BOOK 37, PAGE 251

(PRIVATE)

GRASSING DET	AIL	GRASSING DETAIL		
SEEDING MIXTURE SPECIES	APPLICATION RATE	SEEDING MIXTURE SPECIES	APPLICATION	
LATE WINTER & EARLY SPRING:		FALL & WINTER:		
Rye (grain)	100 (lb/acre)	Tall Fescue (blend of two or	200 (lb/acr	
Annual Iespedeza (Kobe in Piedmont		three improved varieties)	•	
and Coastal Plain, Korean in Mountains)	50 (lb/acre)	Rye (grain)	25 (lb/acre)	
Omit annual Iespedeza when duration				
of temporary cover is not to extend beyond June		SPRING & SUMMER:		
		Pensacola Bahiagrass	50 (lb/acre)	
SUMMER:		Sericea Lespedeza	30 (lb/acre)	
German Millet		Common Bermudagrass	10 (lb/acre)	
In the Piedmont and Mountains,	40 (lb/acre)	German Millet	10 (lb/acre)	
a small-stemmed sundangrass may be		Tall Fescue	50 (lb/acre)	
substituted at a rate of 50 (lb/acre)				
TAXX		SEEDING DATES		
FALL:				
Rye (grain)	120 (lb/acre)	FALL & WINTER:		

SEEDING DATES

FES I.E. 27.23 CURBING

D.B. 1452-839 Zoning: CB

Land Use: Vacant

LATE WINTER & EARLY SPRING: Mountains - Above 2500 ft: Feb. 15-May 15 Piedmont - Jan. 1-May 1 Coastal Plain - Dec. 1-Apr. 15

Mountains - May 15-Aug. 15

Piedmont - May 1-Aug. 15 Coastal Plain - Apr. 15-Aug. 15

Mountains - Aug. 15-Dec. 15 Coastal Plain and Piedmont - Aug. 15-Dec. 30

limestone and 750 lb/acre 10-10-10 fertilizer.

SOIL AMENDMENTS:

Follow recommendations of soil tests or apply 2,000 lb/acre ground agricultural

MULCH:

apply 4,000 lb/acre straw. anchor straw by tacking with asphalt, netting, or a

mulch anchoring tool. A disk with blades set nearly straight can be used as a mulch anchoring tool.

Refertilize if growth is not fully adequate. reseed, refertilize and mulch immediatel following erosion or other damage.

NORTH CAROLINA PERMANENT CDASSING DETAIL

SEEDING MIXTURE SPECIES	APPLICATION RA
FALL & WINTER: Tall Fescue (blend of two or	200 (lb/acre)
three improved varieties) Rye (grain)	25 (lb/acre)
SPRING & SUMMER:	
Pensacola Bahiagrass	50 (lb/acre)
Sericea Lespedeza	30 (lb/acre)
Common Bermudagrass	10 (lb/acre)
German Millet	10 (lb/acre)
m 11 n	(11 /

FALL & WINTER:	
January - April	
August - December	

SOIL AMENDMENTS

Apply lime and fertilizer according to soil tests, or apply 3.000-5,000 lb/acre ground agricultural limestone (use the lower rate on sandy soils) and 1,000 lb/acre 10-10-10 fertilizer.

Fertilize according to soil tests or apply 40 lb/acre nitrogen in January or february, 40 lb in September and 40 lb in November, from a 12-4-8, 16-4-8, or similar turf fertilizer. Avoid fertilizer applications during warm weather, as this increases stand losses to disease. Reseed, fertilize, and mulch damaged areas immediately. mow to a height of 2.5-3.5 inches as needed.

SPRING & SUMMER:


April 1 - July 15

Apply lime and fertilizer according to soil tests, or apply 3,000 lb/acre ground agriculture limestone and 500 lb/acre 10-10-10 fertilizer.

MAINTENANCE:


Refertilize the following april with 50 lb/acre nitrogen. Repeat as growth requires. may be moved only once a year. Where a neat appearance is desired, omit sericea and mow as often as needed.


apply 4,000 lb/acre straw. anchor straw by tacking with asphalt, netting, or a mulch anchoring tool. A disk with blades set nearly straight can be used as a mulch anchoring tool.

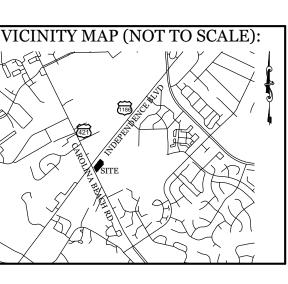

REVISIONS -12-22 ADDED DEAD 22" & 29" LAUREL AKS TO BE REMOVED AND 15" LAUREL OA O BE RELOCATED.



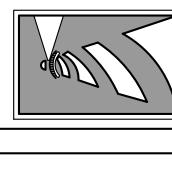

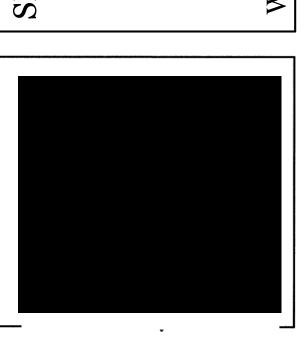

CLIENT INFORMATION: Andy Lazzaro Three Guys Car Wash, Llc

> JAE SHEET SIZE: 24 X 36


CHECKED: CDC DATE: 1/31/2022 CDC | SCALE: APPROVED: 1" = 30' PROJECT NUMBER: 2021-035

DRAWING NUMBER:

5520 Oleander Dr.

Wilmington, NC 28403



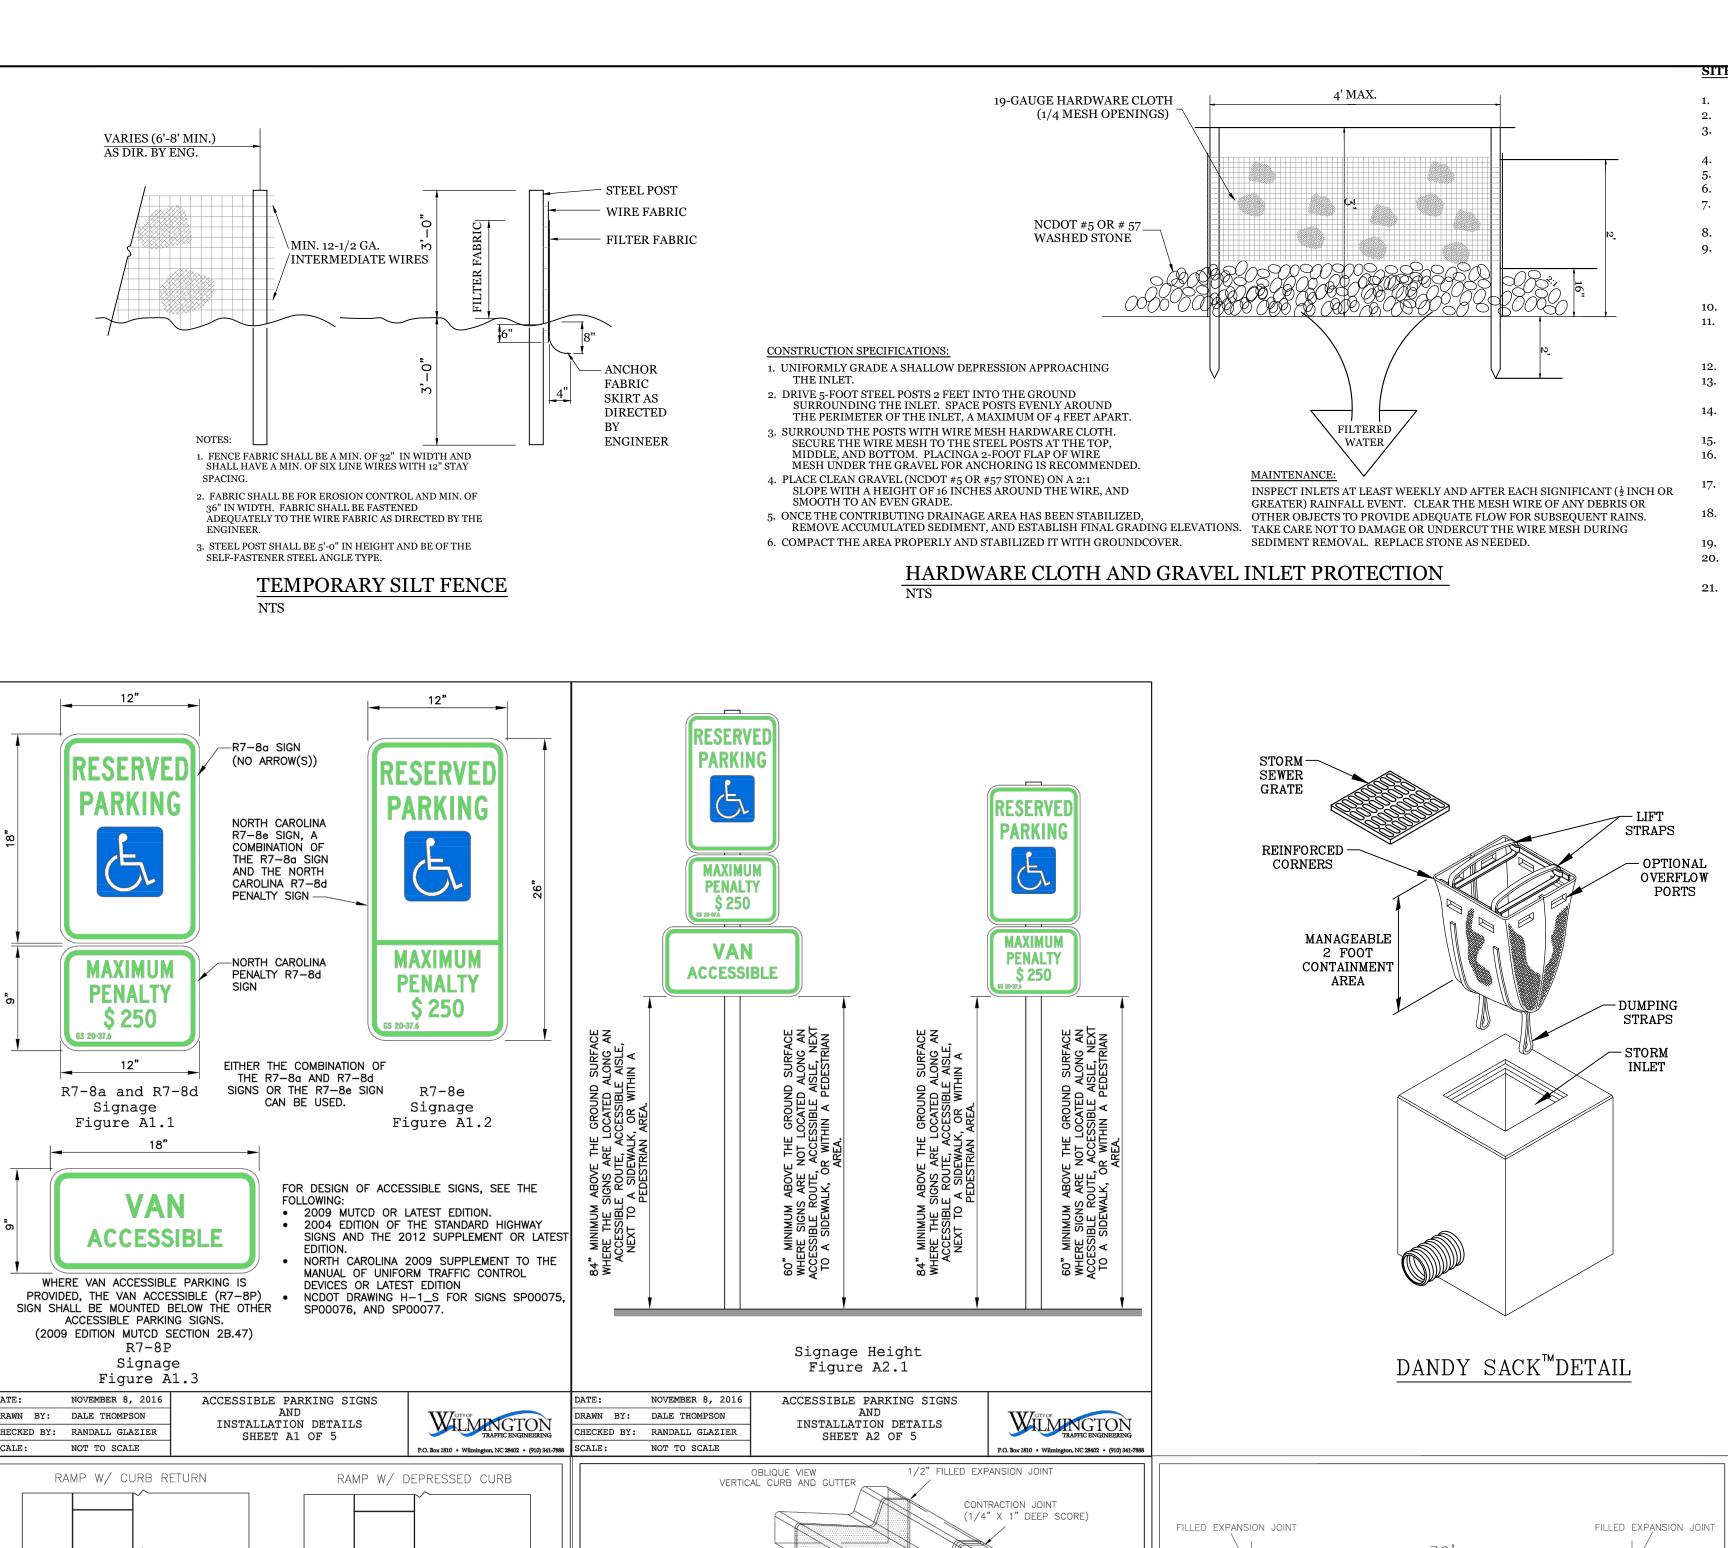

LANDING

__A

MIN. LANDING WIDTH = RAMP WIDTH

1.6-2.4" (TYP)

MAX SLOPE 2% IN ANY DIRECTION

1.5±0.5%

JOINT (T

PLAZA OR OTHER

NON-WALKING SURFAC

1.0-8.3% (30"MAX RISE)

SECTION A-A

RAMP WIDTH

WARNING DOME NOTES: 1. USE CONTRASTING COLORS, RED OR BLACK ON WHITE PAVEMENT 2. USE CAST IN PLACE PAVERS FOR NEW CONSTRUCTION.

STANDARD DETAIL

PERPENDICULAR CURB

RAMP

ADJACENT TO PLAZA

3. RUBBER MATS ARE PERMITTED FOR RETROFITS.

4. LANDING AND RAMP WIDTH MAY BE REDUCED TO 3' WHERE SPACE

IS LIMITED AND DESIGN IS APPROVED BY THE CITY ENGINEER.

WARNING DOMES

SIDEWALK

WARNING

DOMES

CURB AND GUTTER

LANDING

PLAZA OR OTH

NON-WALKING

A ROUNDED CONCRET

SURFACE

4' min

→ | **→** 2'

SECTION B-E

4' MIN

SECTION C-C CURB

TRUNCATED DOMES

OF BASE (TYP)

BASE DIAMETER 0.9-1.4 TOP DIAMETER 50-60%

WILMINGTON

SD3-08

CITY OF WILMINGTON ENGINEERING

AGGREGATE BASE COURSE

VERTICAL CURB AND GUTTER

24" 12"

AGGREGATE BASE COURSE

3. MINIMUM INSTALLATION LENGTH IS 5 FT.

NOTES: 1. EXPANSION JOINT MATERIAL TO COMPLY WITH CURRENT NCDOT STANDARDS

STANDARD DETAIL

CURBING

2, 50' MAX EXPANSION JOINT SPACING, 10' MAX CONTRACTION JOINT SPACING

4. CONCRETE TO BE 3000 PSI MIN 5. VERTICAL CURB AND GUTTER BASE CAN BE SLOPED 3/4" OR USE A FLAT BASE

MEDIAN VERTICAL CURB AND GUTTER

DATE: AUGUST, 2011

SCALE ____NOT TO SCALE_

DRAWN: PB/JSR

CHECKED: DEC

SLOPE CURB

GRANITE CURB

CITY OF WILMINGTON ENGINEERING

SD 3-11

DRAWN: PB/JSR

CHECKED: DEC

SCALE NOT TO SCALE

-12"-- AGGREGATE BASE COURSE

HEADER CURB

VERTICAL CURB

SURFACE

SIDEWALK

WARNING

1.6-2.4" (TYP)


DATE: DECEMBER, 2010

SCALE NOT TO SCALE

DRAWN: PB/JSR

CHECKED: DEC

DOMES

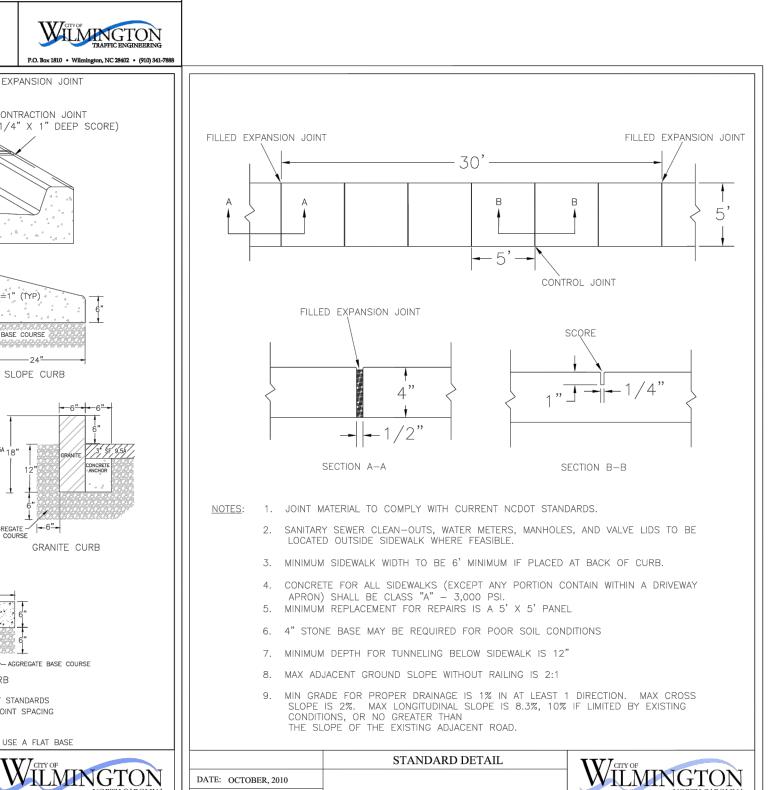

SIDEWALK

CITY OF WILMINGTON ENGINEERING

SD 3-10

PO BOX 1810 WILMINGTON N.C. 28402

1. THE CONTRACTOR SHALL VISIT THE SITE AND BECOME FAMILIAR WITH EXISTING CONDITIONS BOTH ON AND ADJACENT TO THE SITE

CLEARING: CONTRACTOR SHALL REMOVE ALL TREES AND VEGETATION WITHIN LIMITS OF CONSTRUCTION UNLESS OTHERWISE DESIGNATED TO REMAIN. GRUBBING AND STRIPPING: CONTRACTOR SHALL RAKE AND REMOVE ROOTS, STUMPS, VEGETATION, DEBRIS, EXISTING STRUCTURES ABOVE AND BELOW GRADE, ORGANIC MATERIAL OR ANY

MUCKING: CONTRACTOR SHALL COORDINATE WITH OWNER AND THEIR GEOTECHNICAL REPRESENTATIVE TO COORDINATE REMOVAL OF ANY SOFT AREAS.

DISPOSAL: CLEARED, GRUBBED, STRIPPED OR OTHER WASTE MATERIAL SHALL BE REMOVED FROM SITE AND DISPOSED OF IN A PROPERLY PERMITTED FACILITY.

THE CONTRACTOR SHALL NOTE THAT THE GRADING PLAN MAY NOT REPRESENT A BALANCED EARTHWORK CONDITION. THE CONTRACTOR SHALL BE RESPONSIBLE FOR CUT AND FILL OUANTITIES AND COMPLETE INSTALLATION TO SPECIFIED GRADES THE CONTRACTOR SHALL FURNISH SUITABLE BORROW MATERIAL FROM AN OFF-SITE PROPERLY PERMITTED FACILITY AS REQUIRED

ELEVATIONS AND LOCATIONS OF ALL EXISTING UTILITIES AT ALL CROSSINGS PRIOR TO COMMENCING TRENCH EXCAVATION. IF ACTUAL CLEARANCES ARE LESS THAN INDICATED ON PLAN, THE

NO CONSTRUCTION IS TO BEGIN BEFORE LOCATION OF EXISTING UTILITIES HAS BEEN DETERMINED. CALL "NC ONE-CALL" AT LEAST 48 HOURS BEFORE COMMENCING CONSTRUCTION. THE CONTRACTOR IS RESPONSIBLE FOR THE LOCATION AND PROTECTION OF ALL EXISTING UTILITIES DURING CONSTRUCTION. BEFORE COMMENCING ANY EXCAVATIONS IN OR ALONG ROADWAYS OR RIGHT-OF-WAYS, PUBLIC AREAS OR IN PRIVATE EASEMENTS, THE CONTRACTOR SHALL NOTIFY ALL APPROPRIATE PERSONNEL OF THEIR INTENT TO EXCAVATE, IN WRITING, NOT

12. THE CONTRACTOR SHALL BE RESPONSIBLE TO COORDINATE DISCONNECTION/ RECONNECTION AND/OR THE RELOCATION OF ALL EXISTING UTILITIES WITH APPROPRIATE PERSONNEL. 13. CONTRACTOR SHALL ADJUST ALL MANHOLES, VALVE & CURB BOXES TO FINAL GRADE UPON COMPLETION OF ALL CONSTRUCTION. ANY BOXES DAMAGED OR OTHERWISE DISTURBED BY THE

CONTRACTOR SHALL BE REPAIRED AT THE EXPENSE OF THE CONTRACTOR. 14. THE CONTRACTOR SHALL FIELD VERIFY ALL DIMENSIONS AT THE SITE. FURTHERMORE THE CONTRACTOR SHALL REPORT ALL DISCREPANCIES OR QUESTIONS TO THE ENGINEER PRIOR TO


INSTALLATION 15. THE CONTRACTOR SHALL PROVIDE ANY AND ALL LAYOUT REQUIRED TO CONSTRUCT HIS WORK UNLESS OTHERWISE DIRECTED BY OWNER

16. ALL SERVICE CONNECTIONS SHALL BE INSTALLED TO MEET ALL LOCAL, STATE, AND CFPUA CODES. METERS, TAPS, MATERIALS, WORKMANSHIP AND ALL FEES SHALL BE THE RESPONSIBILITY OF THE CONTRACTOR AND SHALL COMPLY WITH ALL REQUIREMENTS.

AS NECESSARY


18. ALL AREAS SHALL BE GRADED FOR POSITIVE DRAINAGE. CONTRACTOR SHALL REPORT ANY DISCREPANCIES TO THE ENGINEER PRIOR TO INSTALLATION. ALL AREAS SHALL BE SLOPED TO DRAIN AWAY FROM BUILDINGS AT ALL TIMES

19. CONCRETE FOR WALKS, CURBS AND DRIVES SHALL HAVE A MINIMUM COMPRESSIVE STRENGTH OF 3000 PSI @ 28 DAYS - AIR ENTRAINED. 20. FIELD TESTING SHALL BE DONE BY AN INDEPENDENT TESTING LABORATORY PAID FOR BY THE OWNER. FURTHER TESTING REQUIRED DUE TO A FAILED TEST WILL BE PAID FOR BY THE

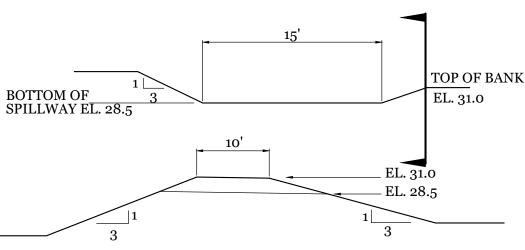


1. WIDTH OF SPILLWAY TO BE PROTECTED WITH RIP-RAP AS SHOWN ON PLAN.


EMERGENCY SPILLWAY DETAIL

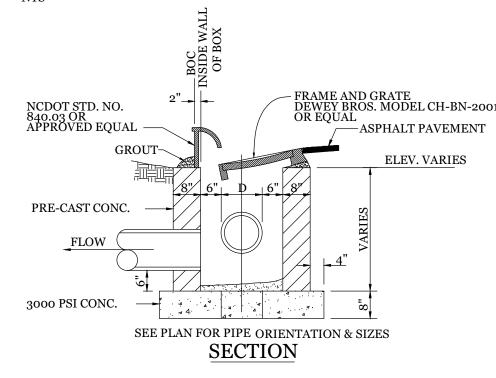


CURB INLET DETAIL

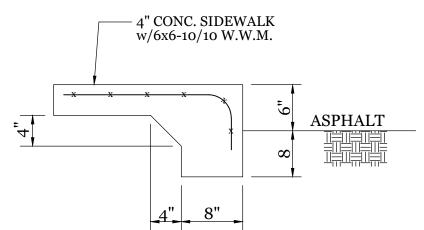

TURNDOWN SIDEWALK

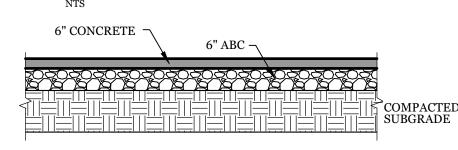


CONCRETE PAVEMENT SECTION

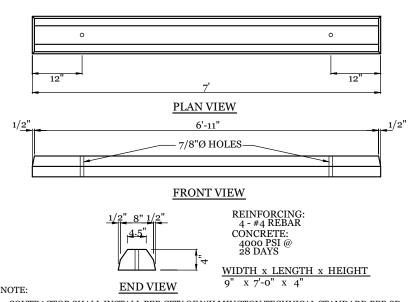

1. CONTRACTOR SHALL INSTALL PER CITY OF WILMINGTON TECHNICAL STANDARD PER SD 15-13 2. CONTRACTOR SHALL INSTALL WHEEL STOP 2.5' FROM SIDEWALK.


WHEEL STOP DETAIL NTS

1. CONTRACTOR MAY USE BRICK WITH MAX. CORBEL 1" PER COURSE 2. CONTRACTOR MAY USE ECCENTRIC M.H. UNIT

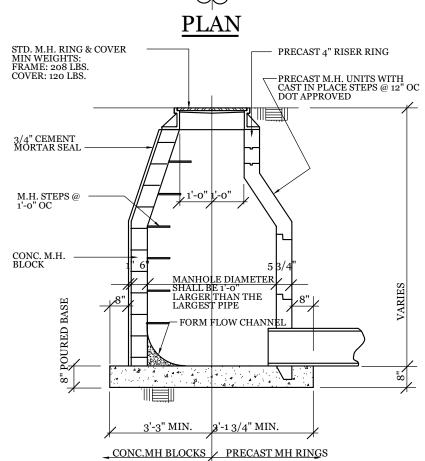

SECTION


STORM DRAIN MANHOLE DETAIL

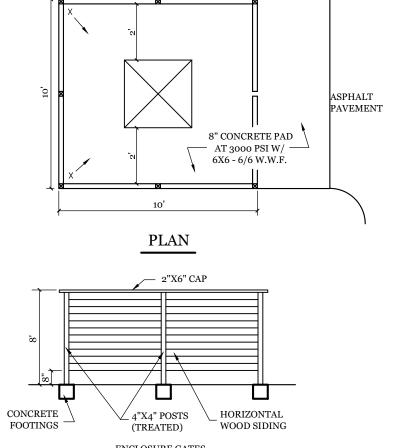


ELEVATIONS


DUMPSTER PAD & ENCLOSURE DETAIL


NTS

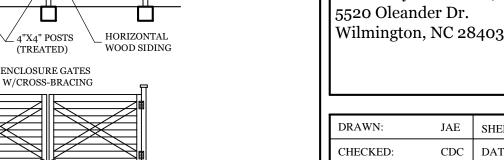


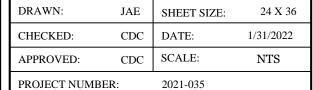


DRAWING NUMBER:

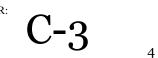


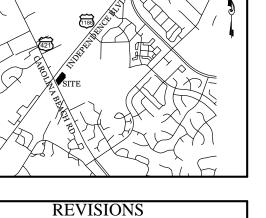

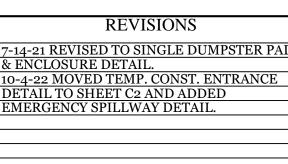


VICINITY MAP (NOT TO SCALE)

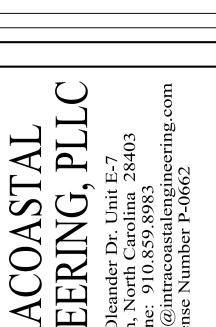

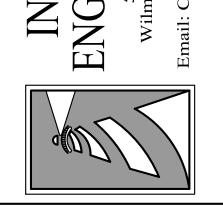




DETAI

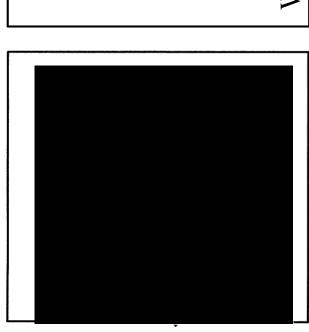



CLIENT INFORMATION:


Three Guys Car Wash, Llc

Andy Lazzaro

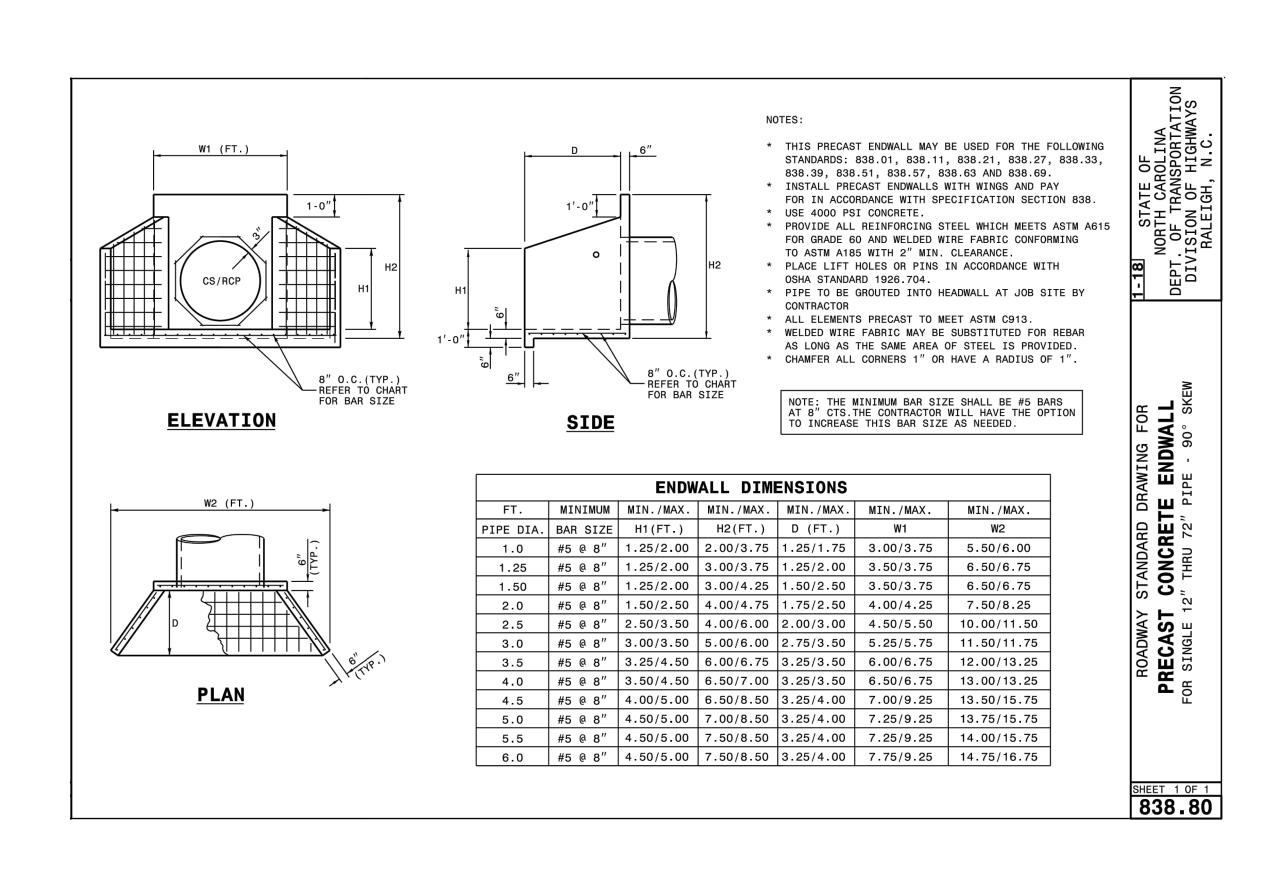


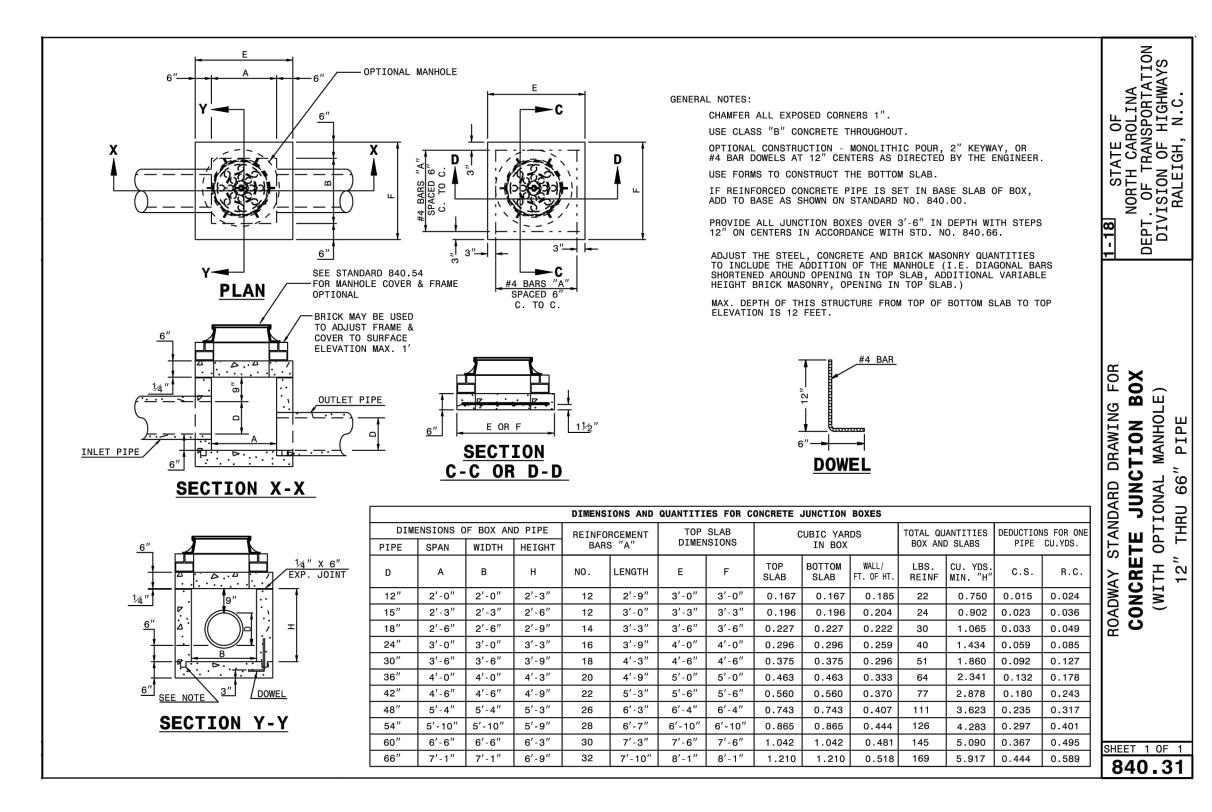


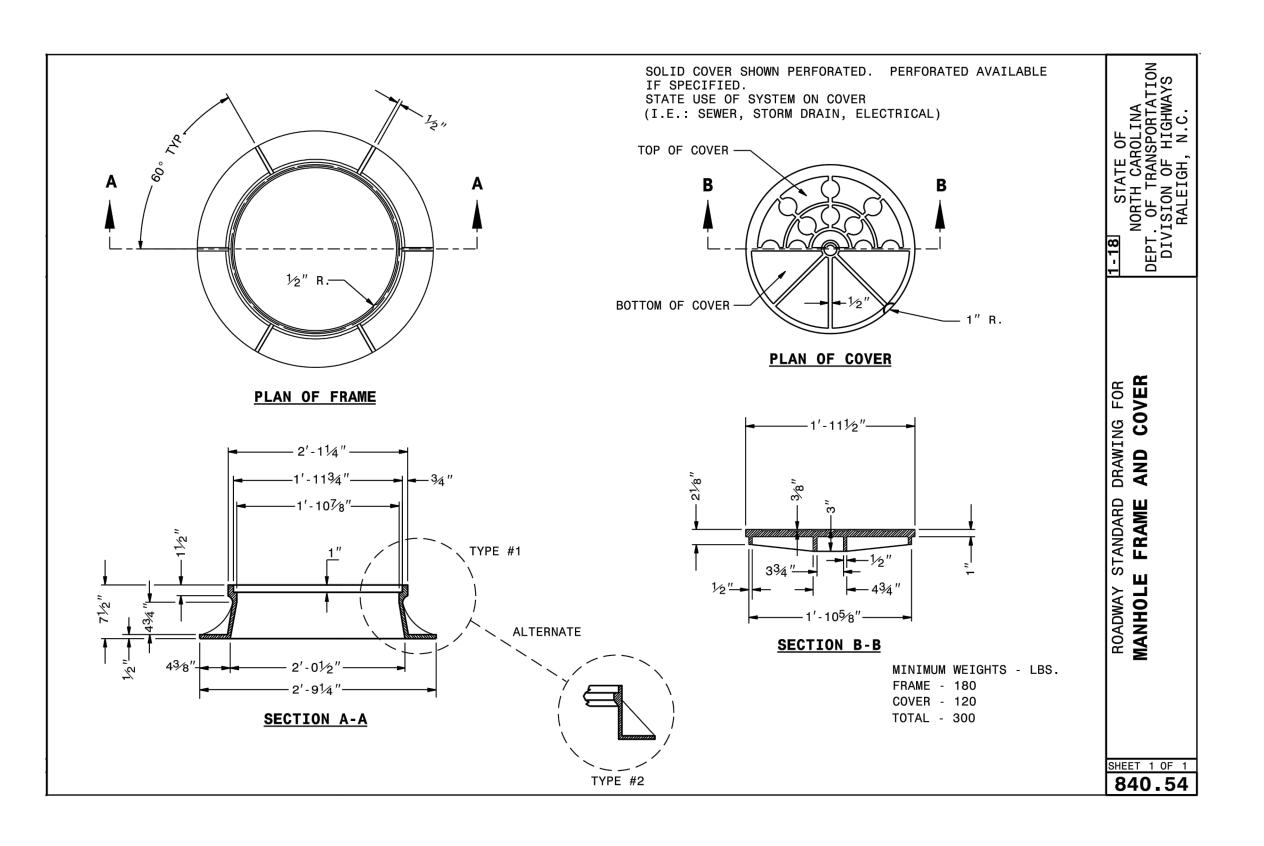


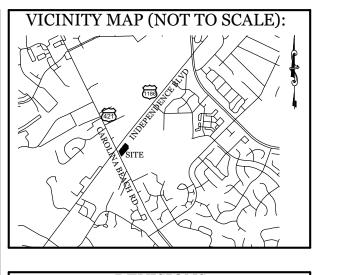

REVISIONS

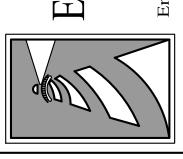

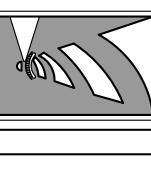

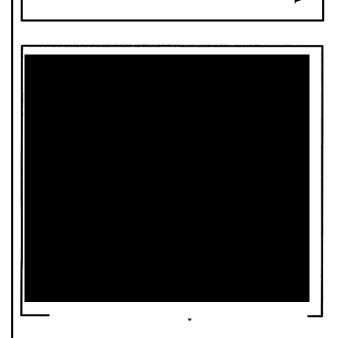


CLIENT INFORMATION: Andy Lazzaro Three Guys Car Wash, Llc 5520 Oleander Dr.

Wilmington, NC 28403

DRAWN:	JAE	SHEET SIZE:	24 X 36
CHECKED:	CDC	DATE:	1/31/2022
APPROVED:	CDC	SCALE:	NTS
PROJECT NUMB	ER:	2021-035	

DRAWING NUMBER:

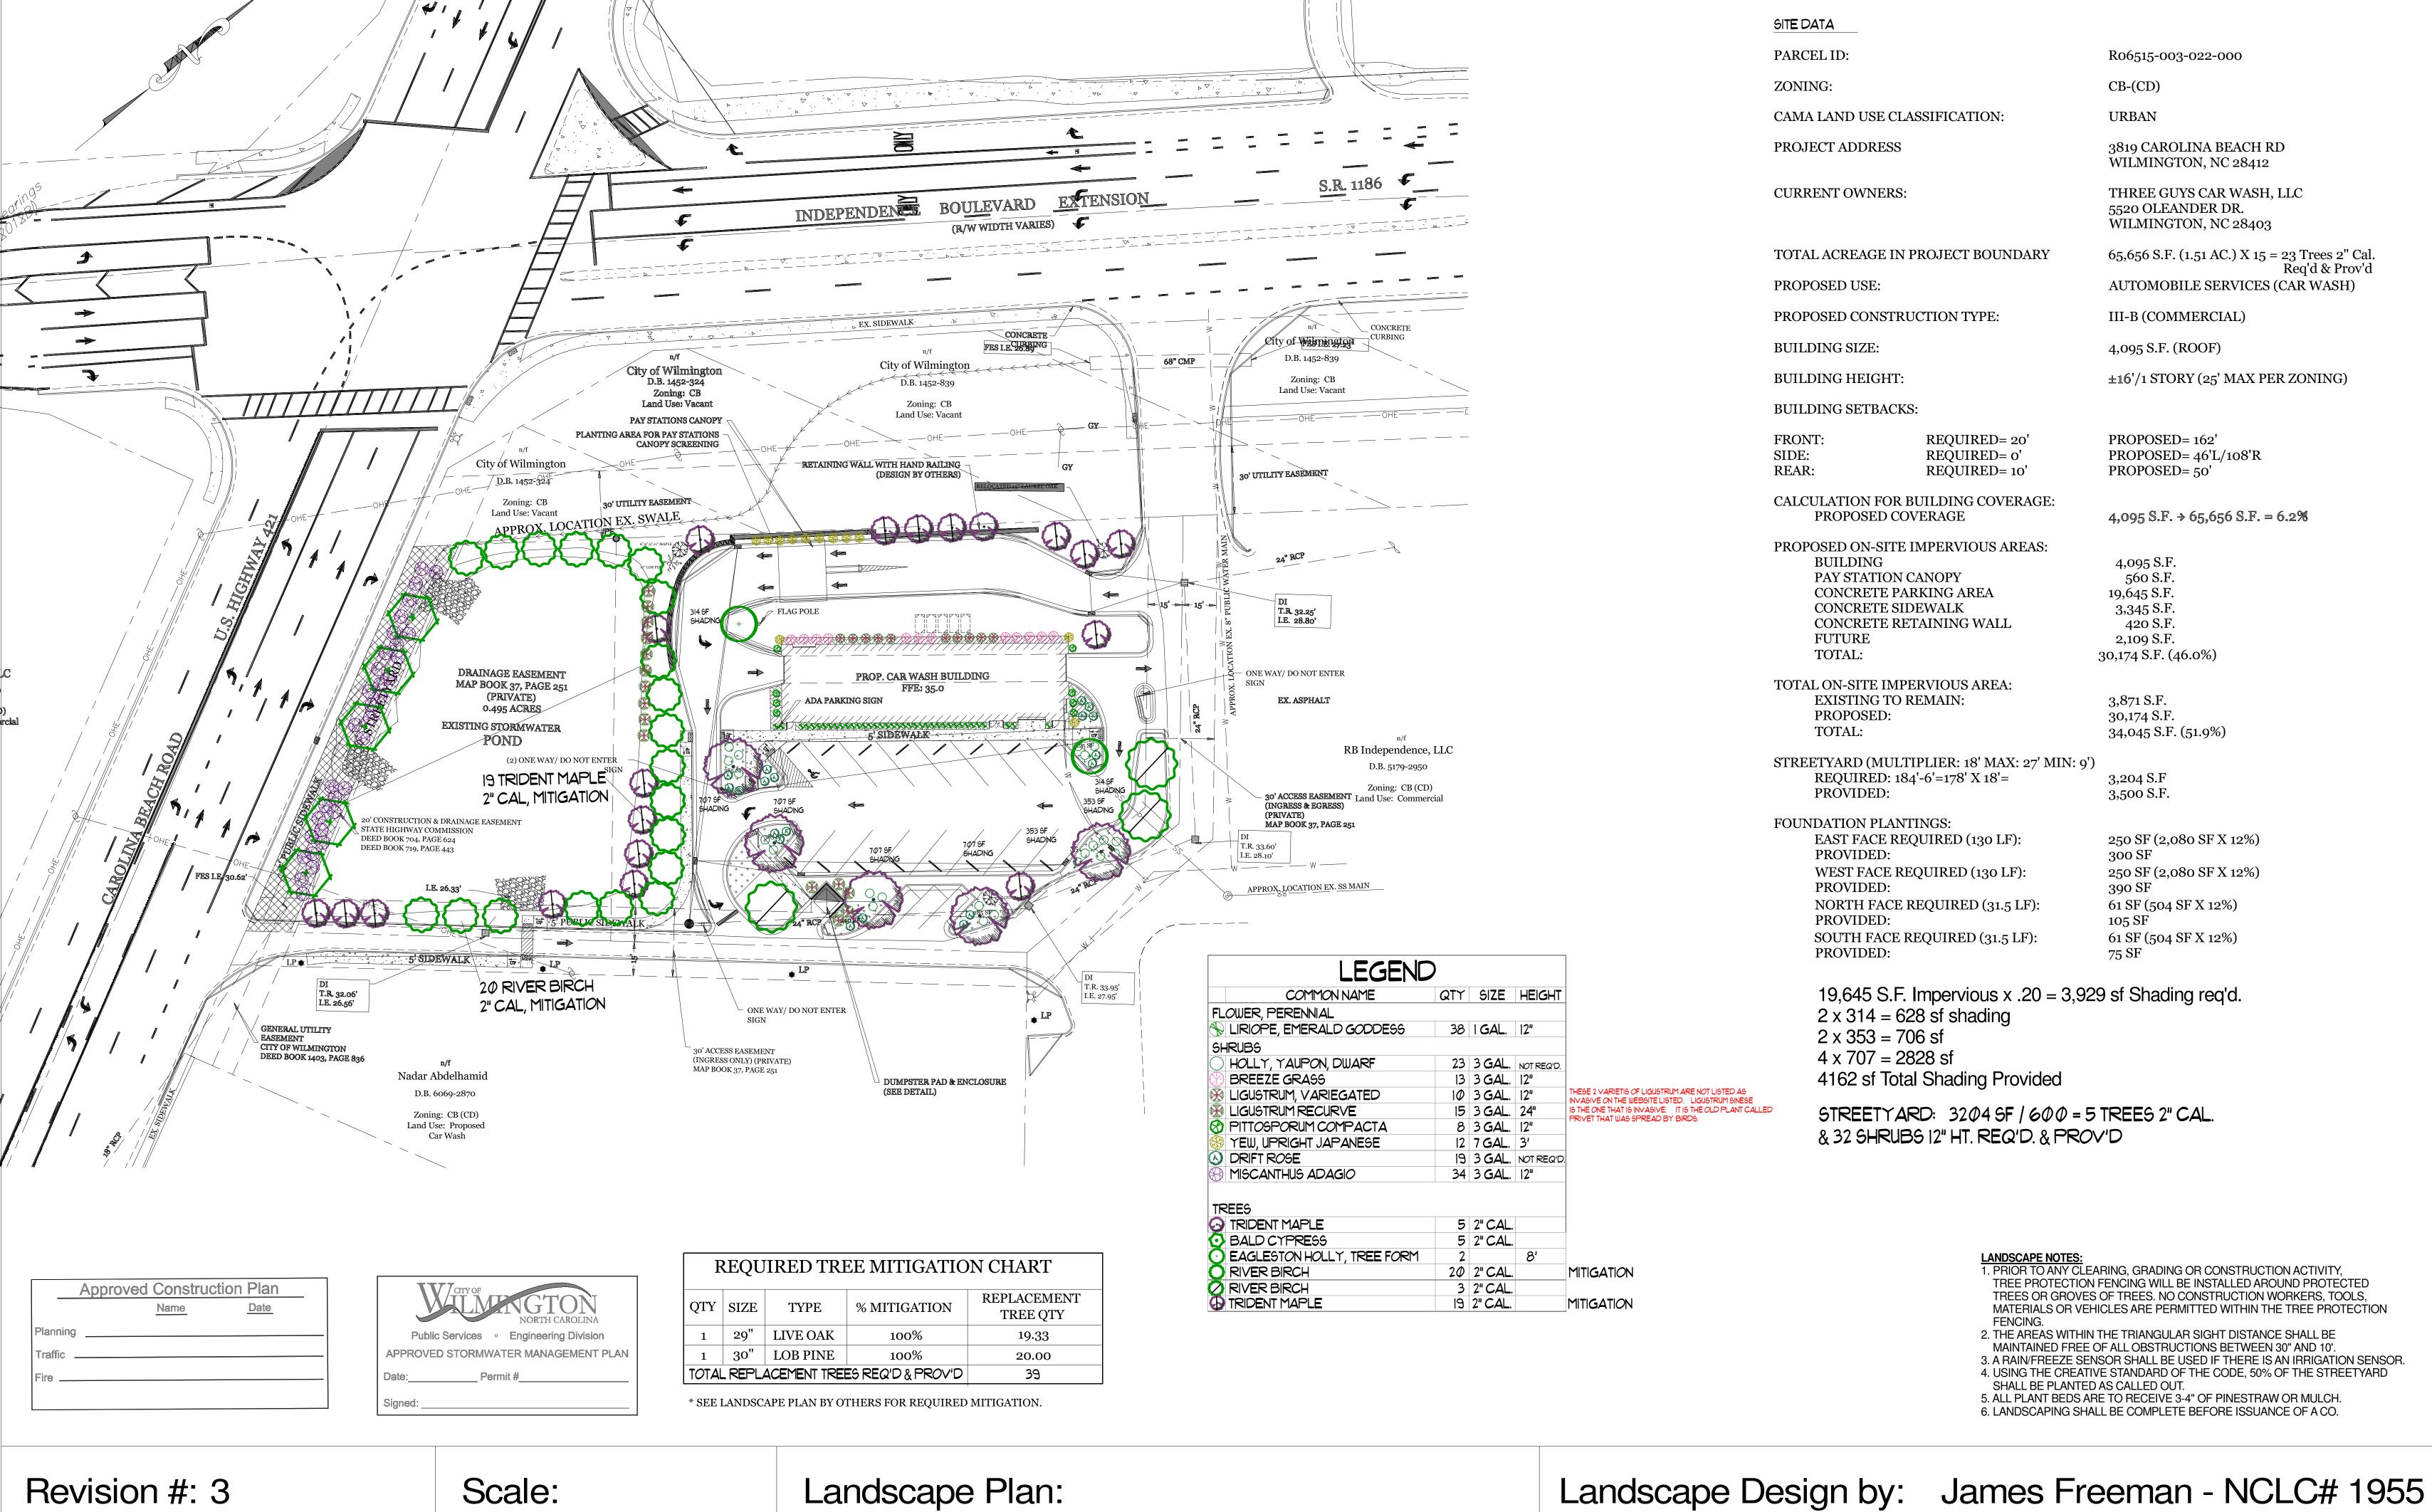

Date: 6/15/2022

1'' = 30'

H2 Turbo Carwash

Freeman Landscape